



6/08

REV LD_195


Downspout Rain Leader Connection

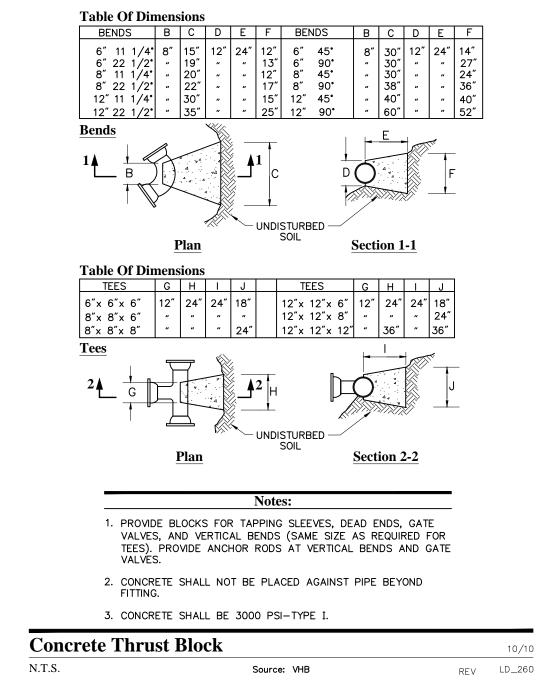

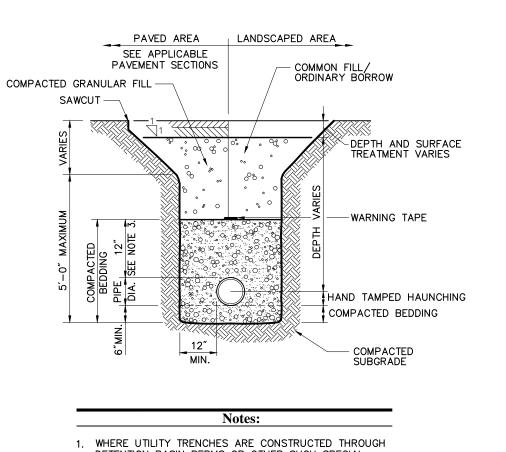

	DETENTION BASIN BERMS OR OTHER SUCH SPECIAL SECTIONS, PLACE TRENCH BACKFILL WITH MATERIALS SIMILAR TO THE SPECIAL SECTION REQUIREMENTS.
2.	USE METALLIC TRACING/WARNING TAPE OVER ALL PIPES.
3.	FOR HDPE PIPE, DIMENSION IS 24 INCHES.

Utility Trench		6/08
N.T.S.	Source: VHB	LD_300

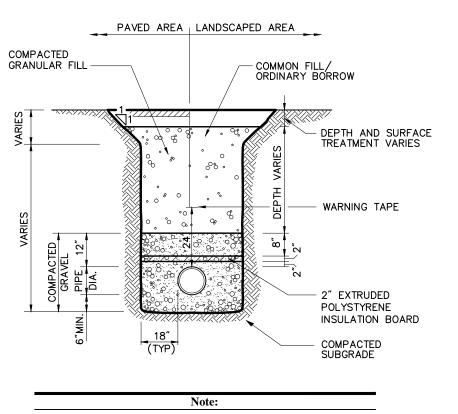

_	Note:
1.	SEWER LINE SHALL BE INSULATED WHEN COVER IS LESS THAN FOUR (4) FEET AND WHERE SHOWN ON PLANS.
2.	BACKFILL PLACED IN UTILITY TRENCHES INCLUDING DISTURBED AREAS SURROUNDING UTILITY TRENCHES SHALL BE PLACED AND COMPACTED IN 12" (MAX.) VERTICAL LIFTS.

ewer Line Insulation		6/08
T.S.	Source: VHB	LD_219

APPROVED I		2,,11,01,01,
TOWN PLAN ANL) ZONING	G COMMISSION
PETITION NO.	38-12, 39)-12, 40-12
AT THE MEETI	NG OF: _	4/10/13
CHAIRMAN: _		
DATE:		

APPROVED BY THE NEWINGTON CONSERVATION COMMISSION
PETITION NO. 2012-28
AT THE MEETING OF: 12/18/12
CHAIRMAN:
DATE:



Vanasse Hangen Brustlin, Inc

COMPLETE I TURNPIKE I, CT 06111 X-TUCK REA TREET N, CT 06840

AR

AUTO




ZONE APPROVAL VP.	(BY/DATE
CONTR.	
RM.	
CM.	
PROPERTY NO.:	00000
6 DIGIT NO.:	00000
4 DIGIT NO.:	000
A OD DDO JEOT NI IMBED.	

AOR PROJECT NUMBER: xxxxxx LOCAL APPROVALS: DATE: 11-26-12 TOWN COMMENTS: DATE: 01-22-13 TOWN COMMENTS: DATE: 04-19-13 TOWN COMMENTS: DATE: 05-08-13

SHEET TITLE:

SITE DETAILS 2

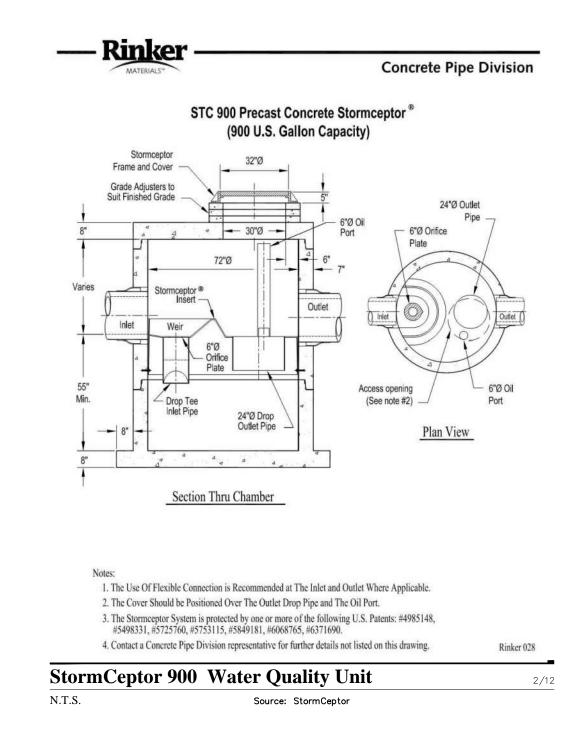

CORBELLING WILL BE PERMITTED.
MAXIMUM CORBEL TO BE 3". NO
PROJECTION SHALL EXTEND INSIDE
OF LIMITS NOTED BY. **

—1" REBAR FOR BAG REMOVAL

-EXPANSION RESTRAINT

Section View

576-SA-1000

(4) - 2-Ton Lift Anchors — Slot for Baffle & Weir Plates (Typical)

Notes:

- Designed in accordance with ASTM C 890 for AASHTO HS20-44 vehicle loading

- Flow Rate 67 GPM based on 15 min. retention time.

PO Box 323, Wilsonville, Oregon 97070-0323

Tel: (503) 682-2844 Fax: (503) 682-2657 Issue Date: Revised 5-1-12 oldcastleprecast.com/wilson

Oil/Water Separator - 1,000 Gallon

Oldcastle Precast

Oil Retaining Baffle — 4" PVC OUTLET PIPE — w/Sampling Tee

4½" -- | -- 6'-9" -- 4½"

PLAN VIEW

Flow Diffuser Baffle -

1'-8½" - 3'-4" 9" - 1'-8½" -

SECTION AA

recommendations:


1.) Ventilate each end to open atmosphere.


2.) Prior to "Start Up" of System, fill with clean water to bottom of outlet pipe (approx. one foot deep).

For best results, fill to flow line.

3.) Follow Regular inspection, Cleaning, & Maintenance Schedule (See Clean Out & Maintenance).

576-SA-1000

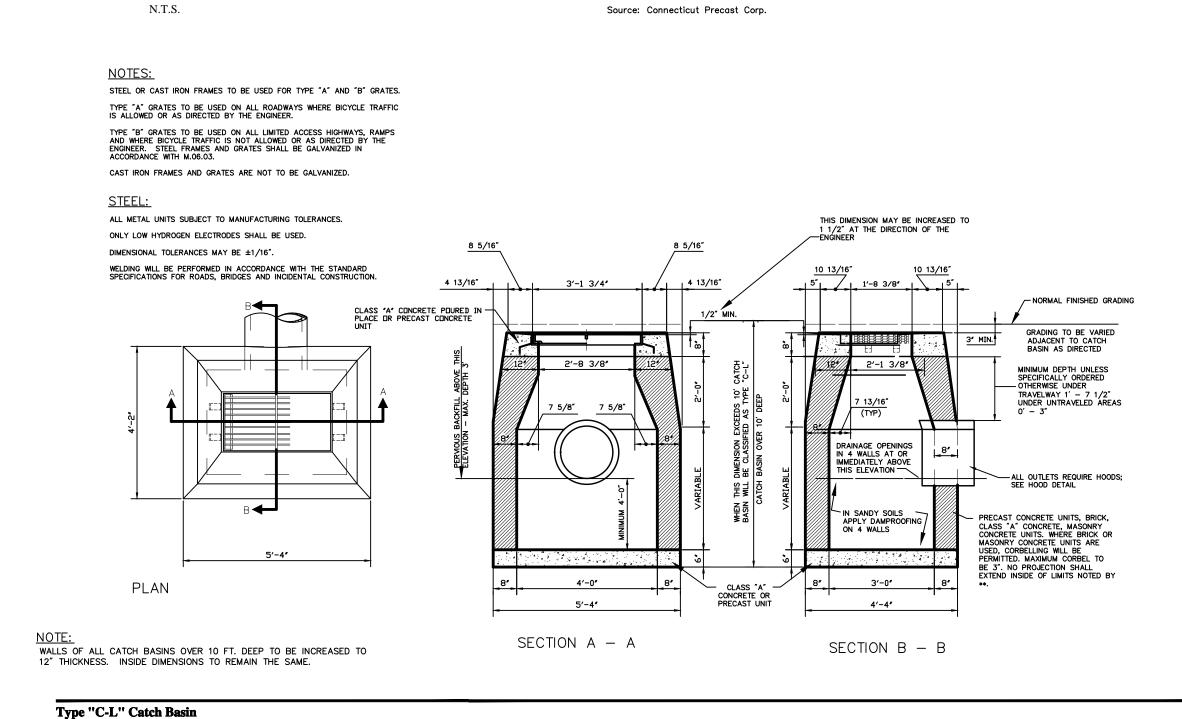

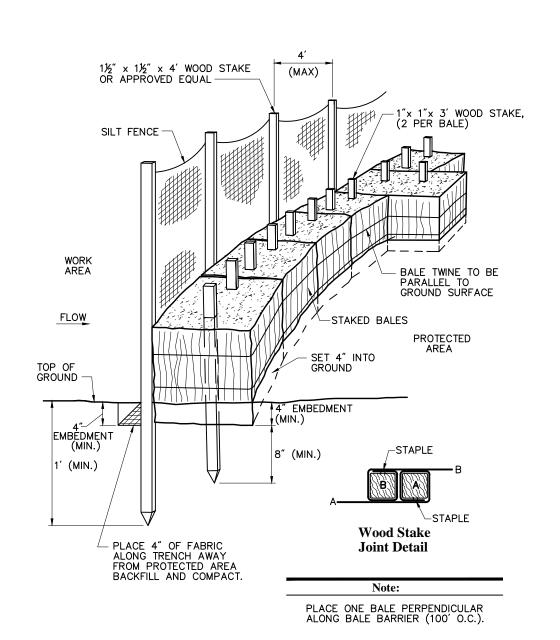

CURB BACK TO BE USED AT LOCATIONS ADJACENT TO EXISTING OR PROPOSED CURB.

SECTION A-A

#4 BARS 4'-0" LONG


ALTERNATE CONSTRUCTION WITH FULL

HOOD DETAIL

WALLS OF ALL CATCH BASINS OVER 10 FT. DEEP TO BE INCREASED TO 12" THICKNESS. INSIDE DIMENSIONS TO REMAIN THE SAME.

N.T.S.

Type "C" Catch Basin

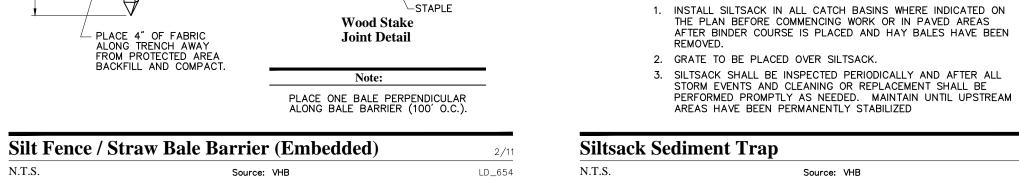


SECTION B-B


CATCH BASIN GRATE

SILTSACK -

CATCH BASIN GRATE-

SILTSACK -

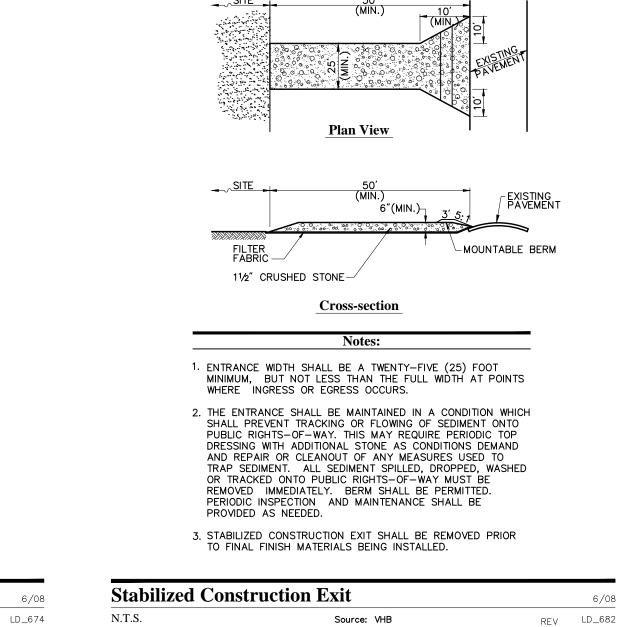

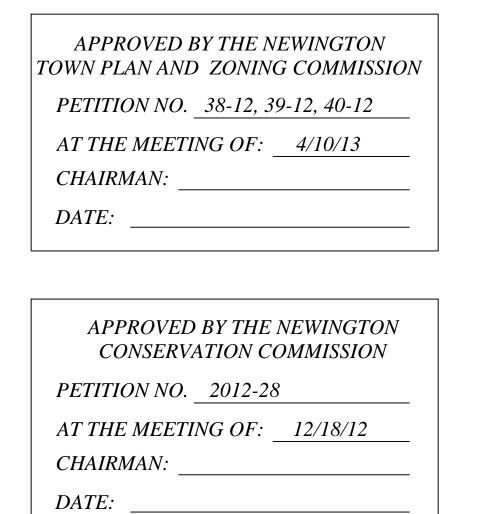



√(4) − 2−Ton Lift Ancho

OIL / WATER SEPARATOR

1000 GALLON - API STYLE

No. 576-T-SA ----

Oil Retaining Baffle

BASE ASSEMBLY No. 576-B-SA 12,585 lbs.

OPTIONAL TOP - HEAVY TRAFFIC

Scale: 3/8" = 1'-0"

576-SA

PO Box 323, Wilsonville, Oregon 97070-0323
Tel: (503) 682-2844
Fax: (503) 682-2657
Issue Date: Revised 12-8-11
oldcastleprecast.com/wilsonvil

No. 576-T-SA-HD

NOTE: PROVIDE FRAME AND COVER RISERS REQUIRED TO

MEET PROPOSED RIM AND

576-SA-1000

OIL / WATER SEPARATOR

1000 GALLON - API STYLE

INVERTS OF STRUCTURE (SEE UTILITY PLAN FOR RIM AND

4,760 lbs.

'anasse Hangen Brustlin, Inc

0

AR


AUTO

-		
	ZONE APPROVAL VP.	(BY/DAT
	CONTR.	
	RM.	
	CM.	
	PROPERTY NO.:	00000
	6 DIGIT NO.:	00000
	4 DIGIT NO.:	000

AOR PROJECT NUMBER: xxxxxx LOCAL APPROVALS: DATE: 11-26-12 TOWN COMMENTS: DATE: 01-22-13 TOWN COMMENTS: DATE: 04-19-13 TOWN COMMENTS: DATE: 05-08-13

SHEET TITLE: SITE DETAILS 3

SHEET NUMBER:

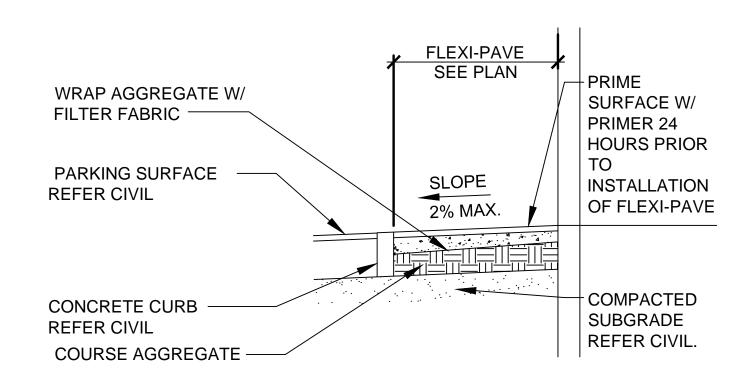


GENERAL NOTES:


- 1. CONTRACTOR TO PROVIDE SUB-GRADE PREP PER MANUFACTURES
- RECOMENDATIONS.
- 2. FINAL SURFACE TO MEET OR EXCEED ADA REQUIRMENTS.

3. PROVIDE COLOR AS DESIGNATED ON SHEET A1.



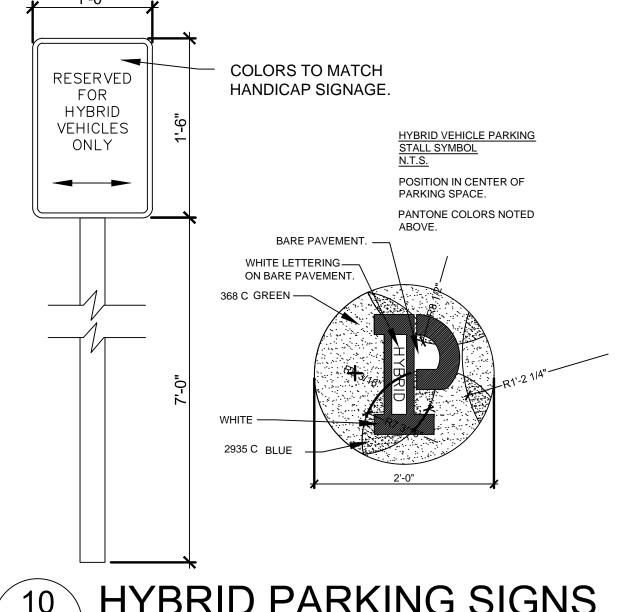


HYBRID PARKING SIGNS SCALE: 1" = 1'-0" (PROVIDED AND INSTALLED BY G.C.)

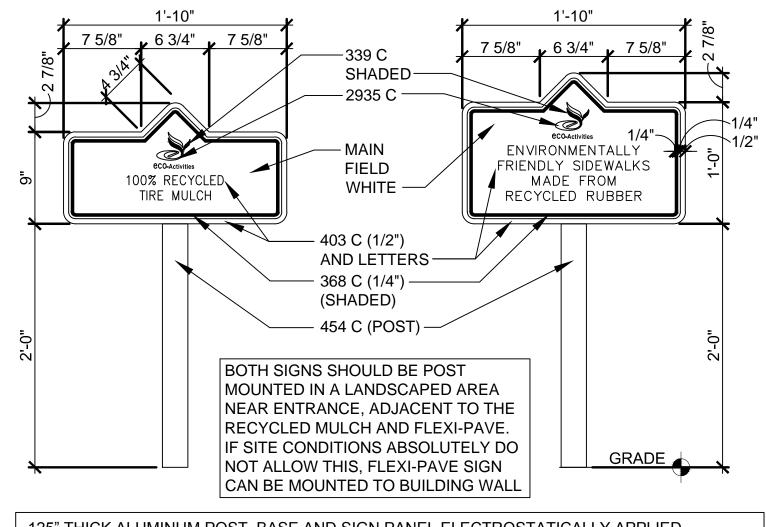



.125" THICK ALUMINUM POST, BASE AND SIGN PANEL ELECTROSTATICALLY APPLIED POWDER PAINT FOR DURABILITY AND RESISTANT TO CHIPPING, PEELING, AND SCRATCHING. GRAPHICS WILL BE VINYL CUT USING 7 YEAR HIGH PERFORMANCE CAST FILM. RECYCLED PLASTIC OR ALUMINUM CONSTRUCTION. PANTONE COLORS NOTED ABOVE.

ECO-ACTIVITY SIGN

SCALE: 1" = 1'-0" (PROVIDED AND INSTALLED BY G.C.)

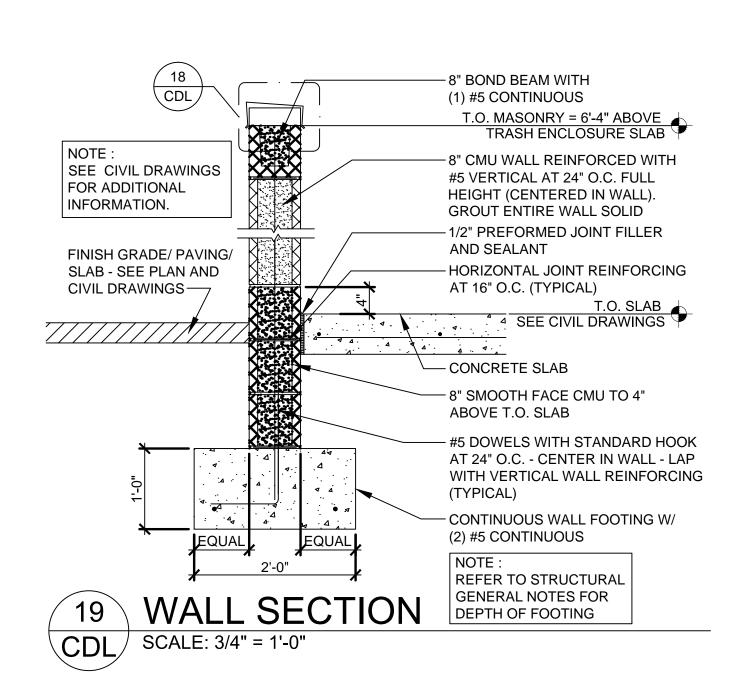


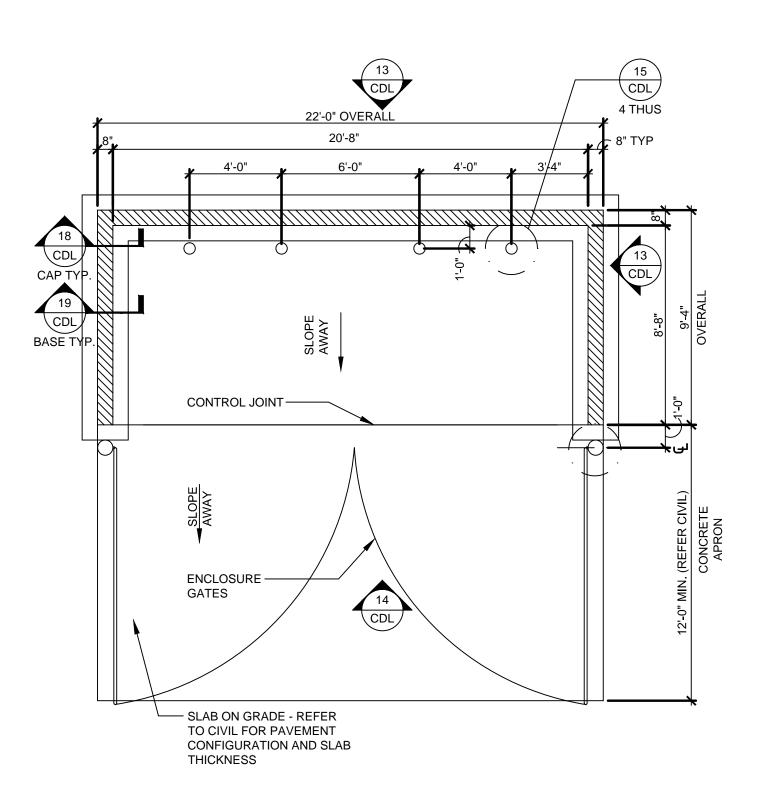


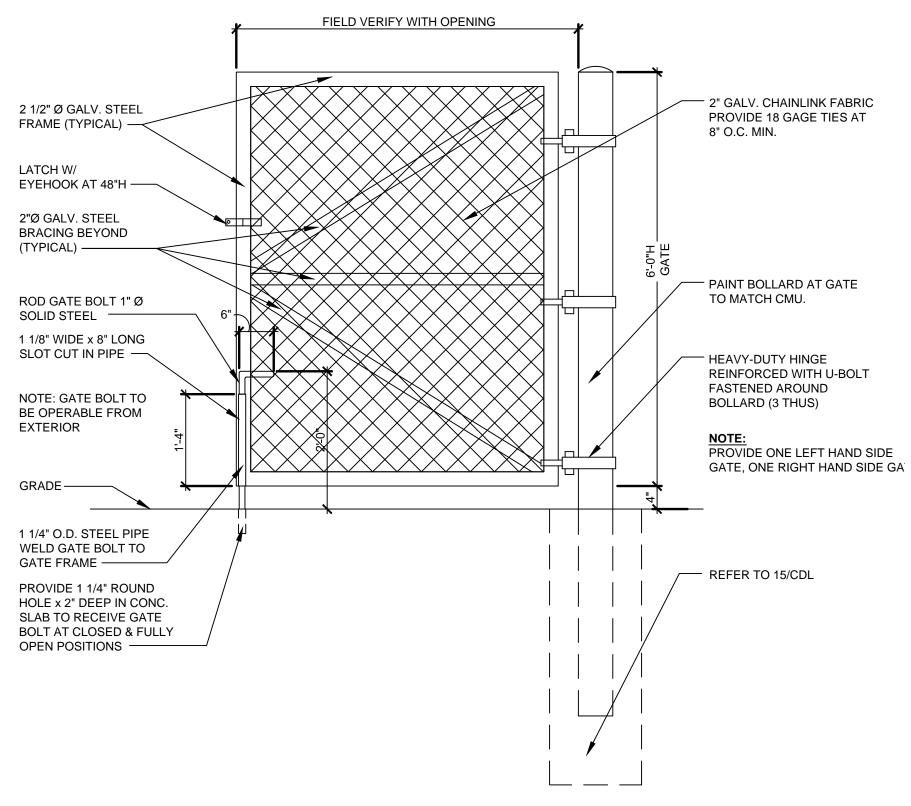





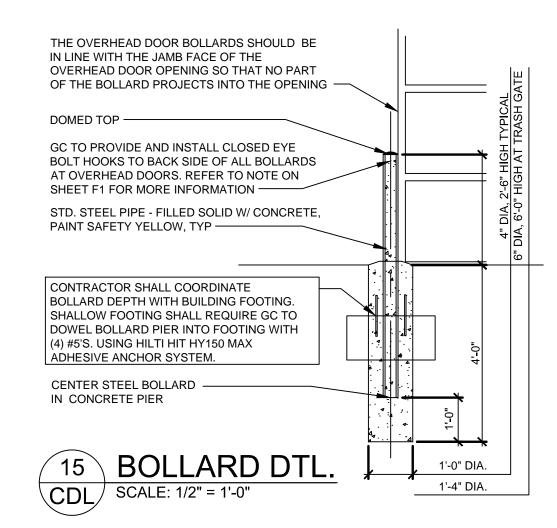

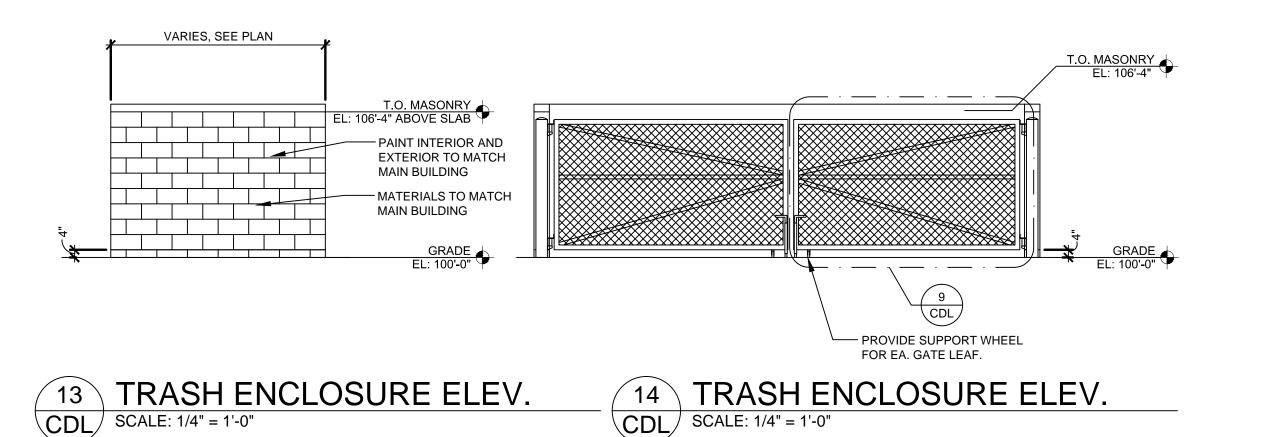

PETITION NO. 38-12, 39-12, 40-12
AT THE MEETING OF: 4/10/13
CHAIRMAN:
DATE:

APPROVED BY THE NEWINGTON CONSERVATION COMMISSION
PETITION NO. 2012-28
AT THE MEETING OF: 12/18/12
CHAIRMAN:
DATE:

anasse Hangen Brustlin, In



ZONE APPROVAL	(BY/D
VP.	
CONTR.	
RM.	
CM.	
PROPERTY NO.:	000
6 DIGIT NO.:	000
4 DIGIT NO.:	0

AOR PROJECT NUMBER: xxxxxx LOCAL APPROVALS: DATE: 11-26-12 TOWN COMMENTS: DATE: 01-22-13 TOWN COMMENTS: DATE: 04-19-13 TOWN COMMENTS: DATE: 05-08-13

SHEET TITLE:

SITE DETAILS 4

HALF GARDEN CORNER BLOCK

NOT-TO-SCALE

MEASURED FROM TOP OF WALL

CURVE DETAIL

TYPICAL CURVES (NOT TO SCALE)

GENERAL NOTES:

SITE PREPARATION:

- 1.1. STRIP ALL VEGETATION, ORGANIC SOILS AND UNSUITABLE FILL SOILS FROM THE WALL ALIGNMENT AREA.
- 1.2. BENCH CUT ALL EXCAVATED SLOPES.
- 1.3. DO NOT OVER EXCAVATE UNLESS DIRECTED TO DO SO BY THE OWNER'S SITE REPRESENTATIVE IN ORDER TO REMOVE UNSUITABLE SOIL.
- 1.4. THE OWNER'S SITE REPRESENTATIVE SHALL VERIFY FOUNDATION SOILS AS BEING COMPETENT PER THE DESIGN STANDARDS AND PARAMETERS.

2. LEVELING PAD & BOTTOM BLOCK:

- 2.1. WHERE THE LEVELING PAD IS CONSTRUCTED ON SUITABLE NATIVE SOILS IT SHALL CONSIST OF DENSE GRADED 3/4" CRUSHED STONE, 12" THICK AND EXTENDING 12" TO EITHER SIDE OF THE BASE BLOCK.
- 2.2. WHERE THE LEVELING PAD IS CONSTRUCTED ON GAP OR RAP PIERS THE LEVELING PAD MATERIAL SELECTION AND
- DESIGN IS THE RESPONSIBILITY OF THE GROUND IMPROVEMENT CONTRACTOR. 2.3. MINIMUM EMBEDMENT OF WALL BELOW FINISH GRADE SHALL BE AS INDICATED ON THE WALL FACE DRAWING.
- 2.4. FOLLOW APPLICABLE PROVISIONS OF THE MANUFACTURER'S INSTALLATION INSTRUCTIONS AND WRITTEN SPECIFICATIONS, ESPECIALLY WITH REGARDS TO LEVELING OF BLOCKS AND BASE.

- 3.1. DRAINAGE FILL SHALL CONSIST OF ASTM #57 SIZE CRUSHED STONE PLACED FOR A DEPTH OF AT LEAST 12" BEHIND THE WALL. A FILTER FABRIC SHALL BE PLACED OVER THE CUT OR FILL FACE BEHIND THE WALL TO PREVENT THE MIGRATION OF SOIL INTO THE DRAINAGE MATERIAL
- 3.2. THE PERFORATED HDPE DRAINS SHALL OUTLET THROUGH THE WALL FACE AT OR NEAR THE LOCATIONS SHOWN ON THE WALL FACE DRAWING.
- 3.3. PLACE A FILTER FABRIC (MIRAFI 140N, OR EQUAL) OVER THE DRAINAGE MATERIAL TO MINIMIZE SOIL MIGRATION FROM THE SURFACE MATÉRIAL (TOPSOIL OR IMPERVIOUS) INTO THE DRAINAGE MATERIAL.

4. BACKFILLING & COMPACTION:

- 4.1. BACKFILL AND COMPACT THE FILL MATERIAL BEHIND THE WALL AS THE WALL IS INSTALLED.
- 4.2. COMPACTION TESTS SHALL BE TAKEN AS THE WALL IS INSTALLED. THE MINIMUM NUMBER OF TESTS SHALL BE DETERMINED BY THE OWNER'S SITE REPRESENTATIVE.
- 4.3. COMPACTION SHALL BE TO A MINIMUM OF 95% OF THE MODIFIED PROCTOR MAXIMUM DRY DENSITY.
- 4.4. RECOMMENDED COMPACTION EQUIPMENT WITHIN 15 FEET OF THE BACK OF THE WALL IS AS FOLLOWS: 0 - 4 FEET HAND TAMP OR VIBRATORY PLATE COMPACTOR 4 - 15 FEET NOTHING LARGER THAN TWO-DRUM, WALK-BEHIND VIBRATORY ROLLER (LARGER ROLLERS CAN BE USED STATICALLY, PROVIDED LIFT SIZE DOES NOT COMPROMISE

5. GENERAL WALL LAYOUT & CONSTRUCTION:


ACHIEVEMENT OF NECESSARY COMPACTION RATES.)

- 5.1. FINAL WALL ALIGNMENT SHALL BE LOCATED IN THE FIELD BY THE OWNER'S SITE REPRESENTATIVE.
- 5.2. PROVIDE LATERAL DRAINAGE SWALES TO DIRECT FLOWS AROUND THE ENDS OF THE WALL AND AWAY FROM THE WALL DURING CONSTRUCTION. DO NOT CONSTRUCT A SWALE BEHIND THE WALL AS PART OF THE FINISHED WALL. GRADE ABOVE THE WALL SO THAT WATER FLOWS OVER THE WALL FACE OR TO A POINT AT LEAST AS FAR BEHIND
- 5.3. TURF, OR SOME ACCEPTABLE FORM OF SOIL EROSION PROTECTION, SHOULD BE ESTABLISHED AT THE TOP OF THE WALL (WHERE REQUIRED) BY THE LANDSCAPE CONTRACTOR AS SOON AS THE WALL IS COMPLETED.
- 5.4. ENDS OF THE RETAINING WALLS SHALL BE BLENDED INTO THE PROPOSED/EXISTING GRADE IN A MANNER SATISFACTORY TO THE OWNER'S SITE REPRESENTATIVE. AT THE ENDS OF A WALL WHERE BLENDING TAKES PLACE, THE ISSUE IS NOT A STRUCTURAL FACTOR BUT AN AESTHETIC FACTOR AND THE OWNER'S SITE REPRESENTATIVE IS QUALIFIED TO MAKE THIS JUDGEMENT
- 5.5. ADHERE CAPS WITH A MINIMUM OF TWO 3/8" DIAMETER BEADS OF CONSTRUCTION ADHESIVE SUCH AS TITEBOND HEAVY DUTY CONSTRUCTION ADHESIVE BY FRANKLIN INTERNATIONAL. MORTAR CEMENT CAN ALSO BE USED.
- 5.6. IF CONDITIONS ARE DIFFERENT THAN THOSE STATED IN THESE DRAWINGS AND SPECIFICATIONS, THE CONTRACTOR MUST CONTACT THE DESIGN ENGINEER PRIOR TO PROCEEDING WITH THE CONSTRUCTION OF THE WALL.
- 5.7. THESE WALLS HAVE BEEN DESIGNED WITH CONSIDERATION OF SEISMIC LOADINGS.
- 5.8. WALL CERTIFICATIONS: OCCASIONALLY A "SIGN OFF" BY THE DESIGN ENGINEER IS NEEDED AFTER COMPLETION OF WALL CONSTRUCTION. IF THIS SERVICE IS NEEDED ARRANGEMENTS MUST BE MADE WITH THE DESIGN ENGINEER PRIOR TO WALL CONSTRUCTION FOR A SERIES OF SITE VISITS TO OBSERVE WALL CONSTRUCTION. ACCEPTANCE LETTERS, SIGN OFFS, CERTIFICATIONS, WARRANTYS, ETC. WILL NOT BE PROVIDED WITHOUT PERIODIC SITE VISITS.
- 5.9. THE BARRIER WALL IS BASED ON DATA PROVIDED BY REDI-ROCK INTERNATIONAL. SEE TEST DATA FOR THE "POURED IN PLACE CONCRETE BEAM" METHOD IN THE REDI-ROCK DESIGN RESOURCE MANUAL.

IT IS THE RESPONSIBILITY OF THE INSTALLER TO REVIEW THE NOTES AND DETAILS ON ALL SHEETS OF THIS PLAN SET

THIS PLAN IS FOR GENERAL DESIGN INFO ONLY AND TO DEMONSTRATE THAT THE PROPOSED RETAINING WALL SYSTEM WILL WORK WITHIN THE SITE CONSTRAINTS AS INTENDED. CONTRACTOR SHALL PROVIDE STAMPED FINAL DESIGN OF THE RETAINING WALL SYSTEMS WITH VEHICLE FORCE PROTECTION OBTAINED FROM THE MANUFACTURER BASED ON THE GEOTECHNICAL RECOMMENDATIONS. RETAINING WALL SYSTEM SHALL BE BY

REDI ROCK WITH NO EXCEPTIONS.

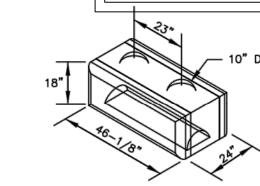

FREESTANDING BOTTOM BLOCK

NOT-TO-SCALE

FREESTANDING MIDDLE BLOCK

APPROVED BY THE NEWINGTON
TOWN PLAN AND ZONING COMMISSION
PETITION NO. 38 12 30 12 40 12

PETITION NO. 38-12, 39-12, 40-12

AT THE MEETING OF: 4/10/13 CHAIRMAN:

APPROVED BY THE NEWINGTON CONSERVATION COMMISSION

PETITION NO. 2012-28 *AT THE MEETING OF:* 12/18/12

CHAIRMAN: DATE:

SHEET NUMBER:

anasse Hangen Brustlin, In

CT 061 CTUCK CTUCK CEET

ZONE APPROVAL (BY/DATE PROPERTY NO.: 000000

000000


4 DIGIT NO.: AOR PROJECT NUMBER: XXXXXX LOCAL APPROVALS: DATE: 11-26-12 TOWN COMMENTS: DATE: 01-22-13 TOWN COMMENTS: DATE: 04-19-13

6 DIGIT NO.:

TOWN COMMENTS: DATE: 05-08-13

SITE DETAILS 5

SHEET TITLE:

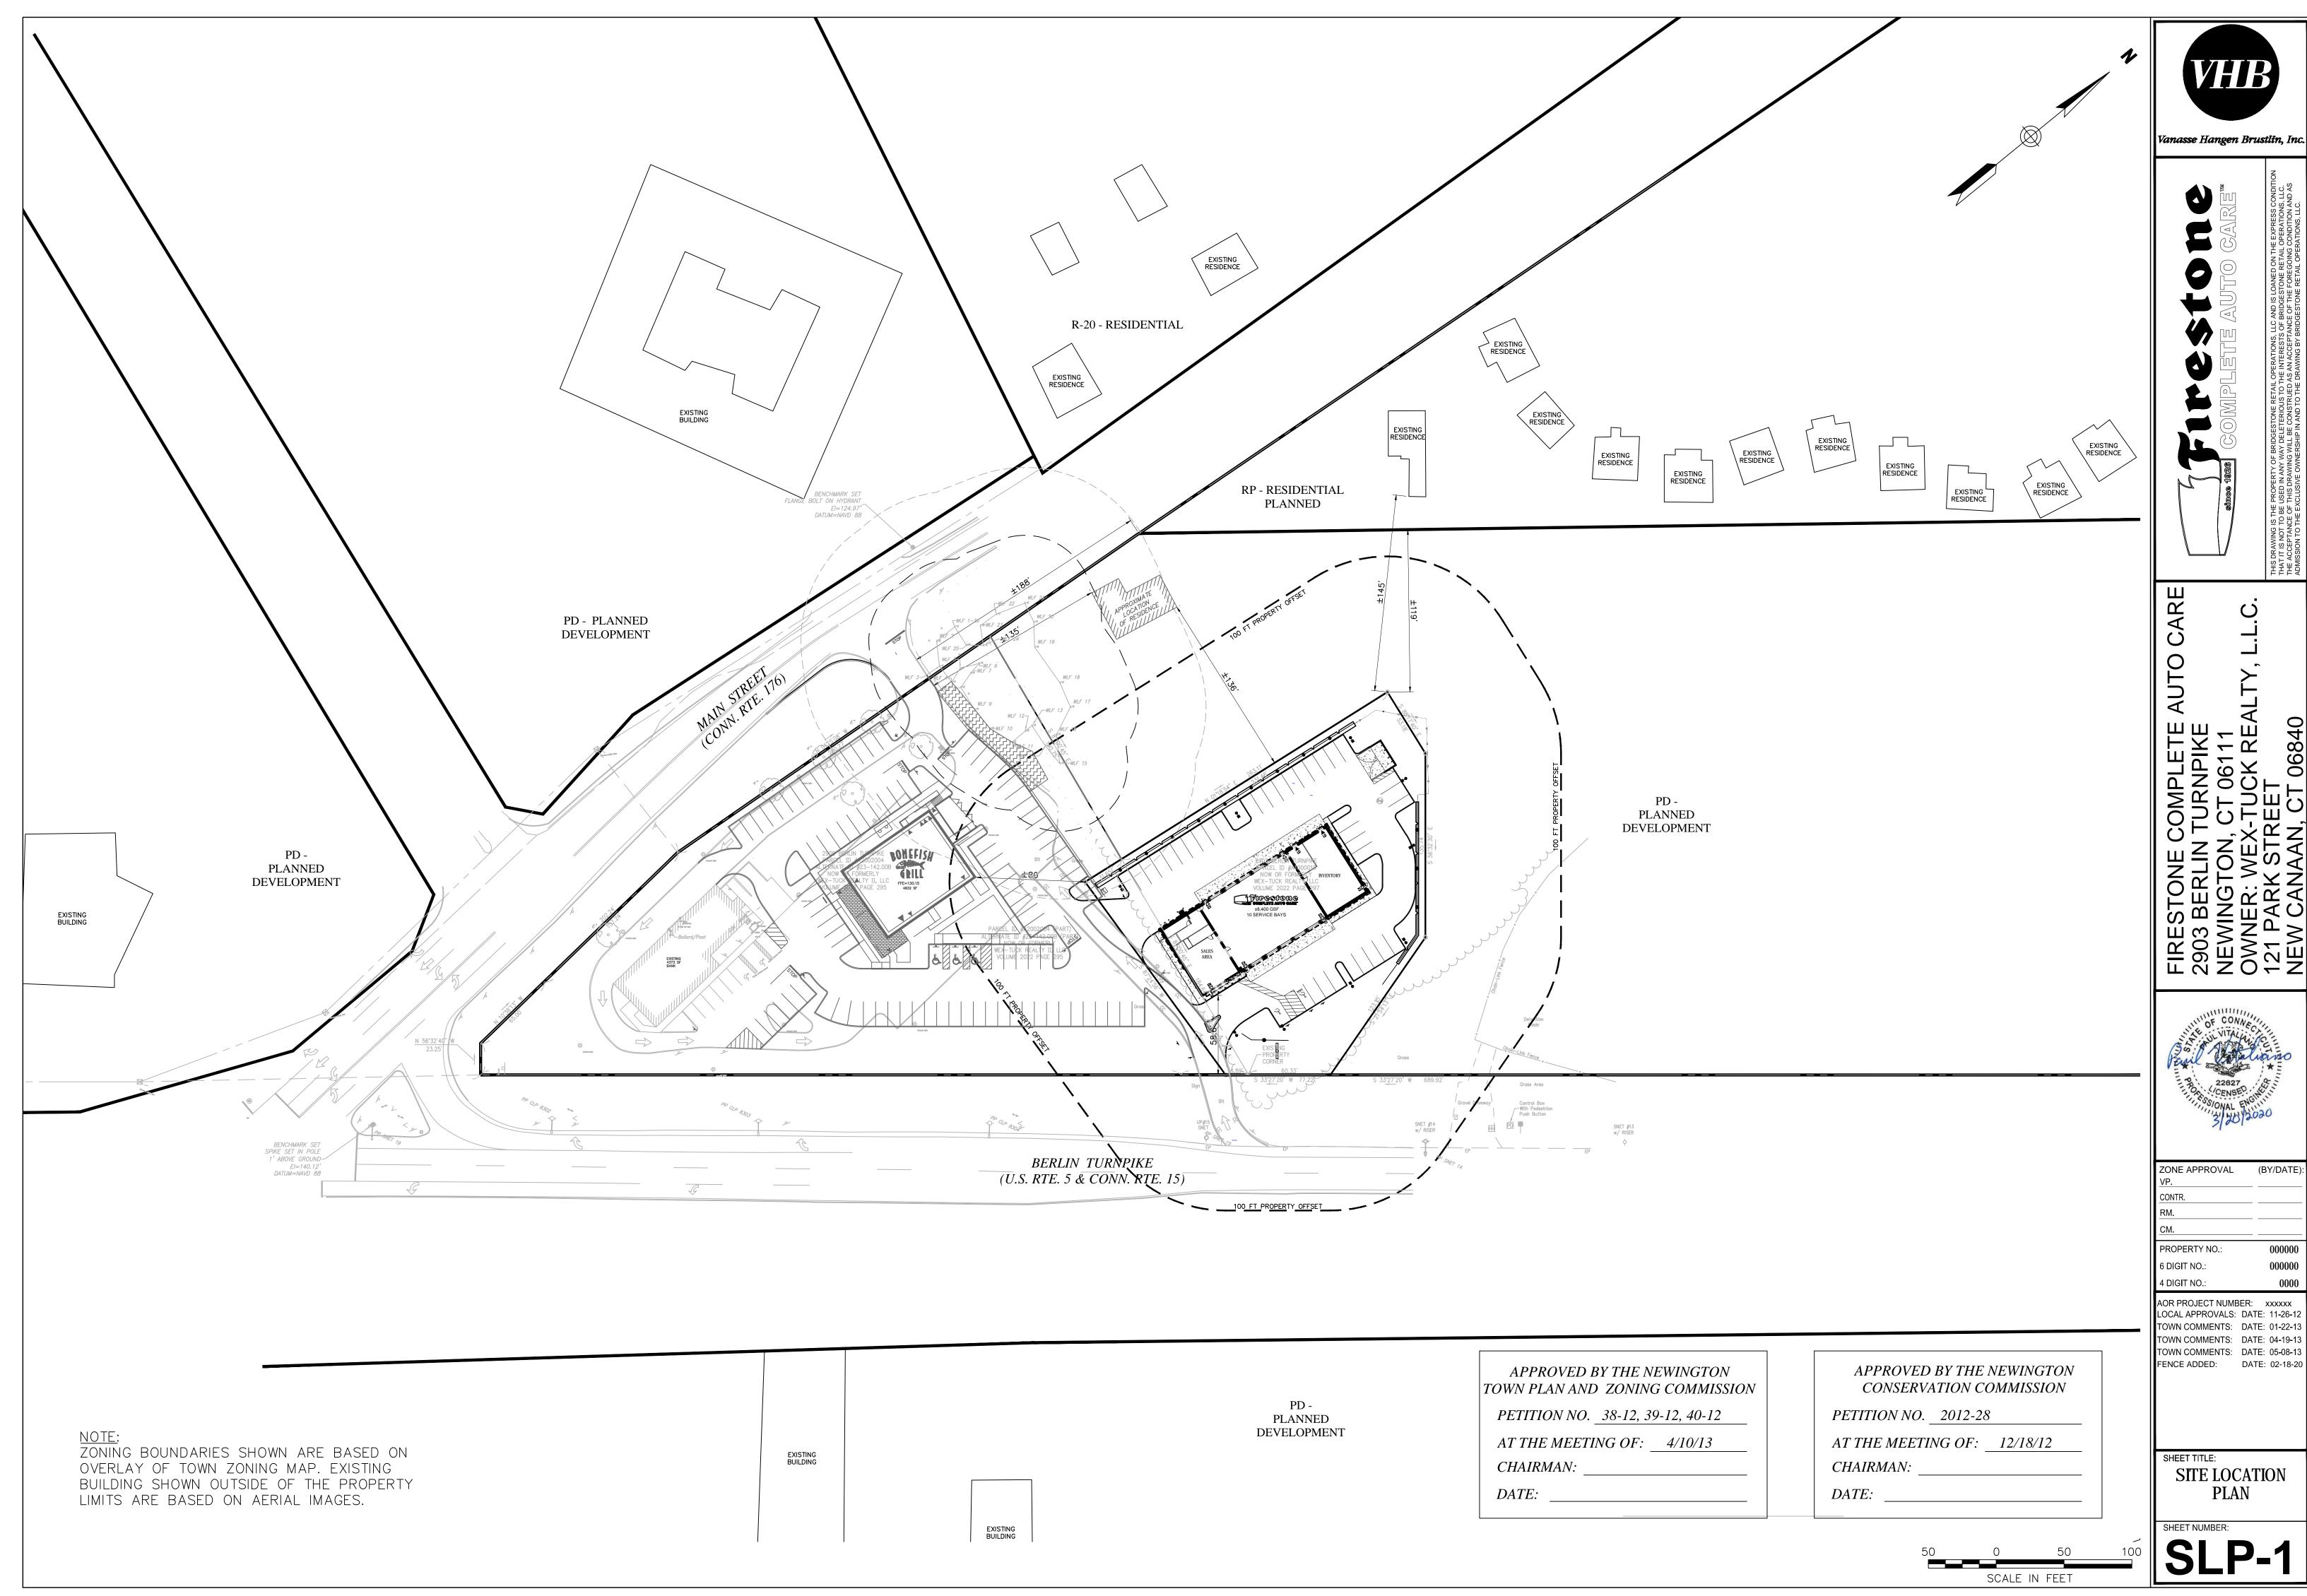

ZONE APPROVAL (BY/DATE):

